COUNTY LINE ROAD SUBDIVISION COUNTY LINE ROAD SITE DEVELOPMENT PLANS


TABLE OF CONTENTS:

GC001	COVER SHEET (01 OF 14)
GC002	NOTES AND LEGEND SHEET (02 OF 14)
CC100	SITE PLAN (03 OF 14)
CC110	UTILITY PLAN (04 OF 14)
CC120	GRADING & EROSION CONTROL PLAN (05 OF 14)
CC130	STREET A PLAN & PROFILE (06 OF 14)
CC131	STREET B PLAN & PROFILE (07 OF 14)
CC132	STREET C PLAN & PROFILE (08 OF 14)
CC500	STORMWATER BASIN "A" DETAILS (09 OF 14)
CC501	STORMWATER BASIN "B" DETAILS (10 OF 14)
CC502	DETAILS (11 OF 14)
CC503	DETAILS (12 OF 14)
CC504	WATER SERVICE DETAILS (13 OF 14)
CC505	SEPTIC DETAILS (14 OF 14)







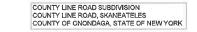



Engineers and Scientists

JUNE 01, 2020

GC001 - COVER SHEE

1. OWNER JORDAN ROAD TOWN HOMES, LLC 4331 JORDAN ROAD

SKANEATELES, NEW YORK 13152

EGGLESTON & KRENZER ARCHITECTS, PC THE TROLLEY BLDG

1391 EAST GENESEE STREET SKANEATELES, NEW YORK 13152

3. TAX ID #: 018.-02-29.1

PARCEL SIZE: 23.03+ ACRES

ZONING CLASSIFICATION: HM - HAMLET DISTRICT

BUILDING SETBACK REQUIREMENTS: FRONT: 30'

7, MINIMUM FRONTAGE WIDTH: 100'

MINIMUM LOT SIZE: 0.50 ACRE (W/ PUBLIC WATER

PROJECT INFORMATION

THIS PROJECT CONSISTS OF CLEARING OF LAND FOR THE PROPOSED. CONSTRUCTION OF 33 RESIDENTIAL BUILDING LOTS WITH ASSOCIATED ROADS, UTILITIES, AND DRIVEWAYS. THE ESTIMATED TIME FOR COMPLETION IS WITHIN ONE (1) YEAR OF RECEIVING ALL NECESSARY PERMITS AND APPROVALS.

SURVEY DATA

FIELD SURVEY WAS COMPLETED BY PAUL JAMES OLSZEWSKI, P.L.S.,

DATUM NOTE

ELEVATIONS AND CONTOURS SHOWN HEREON ARE REFERENCED TO THE NAVD88 DATUM.

NOTIE:
THE LOCATION, SIZES, AND ELEVATIONS OF EXISTING UTILITIES ARE
BASED ON INFORMATION COMPILED BY THE SURVEYOR AND ENGINEER
FROM FIELD WORK, RECORD DRAWINGS AND INFORMATION FURNISHED BY VARIOUS UTILITY COMPANIES WITH FIELD EDITING WHERE JECESSARY AND POSSIBLE THE ACCURACY OF THIS INFORMATION IS NOT GUARANTEED AND SHALL BE VERIFIED BY THE CONTRACTOR.

EROSION CONTROL NOTES


- IT SHALL BE THE CONTRACTOR'S RESPONSIBILITY TO PROVIDE TEMPORARY SOIL EROSION CONTROL AND WATER POLLUTION
- 2. THE CONTRACTOR SHALL CONTROL SURFACE RUNOFF WHICH MAY CONTAIN SUSPENDED SOLIDS FROM ONTO EXISTING PAVEMENT SERVICES IN USE. THIS SHALL BE ACCOMPLISHED BY STAKED BALES OF STRAW OR DIVERSION CHANNELS TO SEDIMENTATION BASINS.
- THE CONTRACTOR SHALL COMPLY WITH ALL PROVISIONS OF THE N.Y.S. DEPARTMENT OF ENVIRONMENTAL CONSERVATION WATER QUALITY CERTIFICATION AND/ OR FRESH WATER WETLANDS PERMIT AND/ OR ARMY CORPS OF ENGINEERS PERMIT (IF APPLICABLE).
- DURING CONSTRUCTION, NO WET OR FRESH CONCRETE OR LEACHATE SHALL BE ALLOWED TO ESCAPE INTO THE WATERS OF THE UNITED STATES, NOR SHALL WASHINGS FROM CONCRETE TRUCKS MIXERS OR OTHER DEVICES BE ALLOWED TO ENTER ANY WETLAND OR WATERS, A CONCRETE WASHOUT SHALL BE USED.
- 5. ALL AREAS OF SOIL DISTURBANCE RESULTING FROM THIS PROJECT SHALL BE SEEDED WITH AN APPROPRIATE PERENNIAL GRASS SEED AND MULCHED WITH STRAW WITHIN ONE WEEK OF FINAL GRADING. MULCH SHALL BE MAINTAINED UNTIL A SUITABLE VEGETATIVE COVER IS ESTABLISHED.
- 6. PERIODIC CLEANING, INSPECTION AND REPLACEMENT OF DEVICES SHALL BE NECESSARY.
- 7. ALL CONTROLS SHALL BE PLACED PRIOR TO STARTING FARTHWORK OPERATIONS AND SHALL REMAIN IN PLACE UNTIL THE NEW SLOPES ARE STABILIZED WITH SEEDING AND/ OR SLOPE PROTECTION.
- 8. WHERE SILT FENCE IS USED IN AREAS OF CONCENTRATED FLOW. THE ENGINEER IN CHARGE MAY CALL FOR BACKING THE FENCE
- 9. ADDITIONAL EROSION AND SEDIMENT CONTROL MEASURES MAY BE REQUIRED DUE TO VARIATIONS IN SITE CONDITIONS.
- 10. IF THERE IS SOME REASON THAT CUT OR FILL CANNOT BE BROUGHT TO FINAL GRADE AND MUST REMAIN UNCOMPLETED FOR A PERIOD OF TIME, IT SHALL BE TEMPORARILY SEEDED AND MULCHED WITHIN

CONSTRUCTION SEQUENCE


- MOBILIZE ALL NECESSARY EQUIPMENT, PERSONNEL AND MATERIAL TO THE MODILIZE ALL NECESSARY LEGIONMENT, FLASOFINEL AND METERAL TO THE SITE, PROCEED WITH INSTALLATION OF EROSION & SEDIMENT CONTROL PRACTICES INCLUDING STABILIZED CONSTRUCTION ENTRANCES, EROSION AND SEDIMENT CONTROL PRACTICES SHALL BE IN PLACE PRIOR TO BEGINNING ANY EARTHWORK OPERATIONS, SCHEDULE AND CONDUCT SITE WALK TO INSPECT SEDIMENT AND EROSION CONTROL MEASURES WITH ENGINEER, MODIFY SEDIMENT AND EROSION CONTROL MEASURES AS NEEDED.
- 2. PROTECT EXISTING INSTRUMENTS, STRUCTURES, VEGETATION AND UTILITIES
- 3. PERFORM CLEARING AND GRUBBING OPERATIONS.
- 4. MASS EARTHWORK OPERATIONS INCLUDING CONSTRUCTION OF WET PONDS
- 6. INSTALLATION OF THE PROPOSED STORM SEWER INLETS AND PIPES,
- 7. INSTALLATION OF THE PROPOSED WATER UTILITY LATERALS AND UNDERGROUND UTILITIES.
- 9. PERMANENT STABILIZATION WITH TOPSOIL, SEED AND MULCH AS SPECIFIED.
- 10. CONSTRUCTION OF THE BIORETENTION FACILITIES ONCE 80% GERMINATION HAS BEEN REACHED AT CONTRIBUTING AREAS.
- WHATEVER MEASURES MAY BE REQUIRED BY THE TOWN OF SKANEATELES.
- 12. PROVIDE ON-GOING MAINTENANCE AND MONITORING OF NEWLY VEGETATED AND RESTORED AREAS AS PER THE CONTRACT DOCUMENTS.
- 13. DEMOBILIZE FROM THE JOB SITE, REMOVE ALL TEMPORARY STRUCTURES. TRASH, DEBRIS, AND OTHER MATERIAL FROM THE SITE, REMOVE TEMPORARY CONTROLS AND SIGNAGE, REMOVE TEMPORARY EROSION SEDIMENT AND EROSION CONTROLS WHERE APPROPRIATE ONCE 80% GERMINATION HAS BEEN REACHED FOR THE ENTIRE SITE.
- 14. NOTIFY ENGINEER OF FINAL STABILIZATION. SCHEDULE AND CONDUCT SITE WALK TO INSPECT SITE WITH ENGINEER.

WATERMAIN NOTES

ALL WATERMAINS SHALL HAVE A MINIMUM 5.0' OF COVER FROM THE TOP OF THE MAIN TO FINISHED GRADE. THE CONTRACTOR SHALL CHECK ALL CUT STAKED BEFORE TRENCHING TO INSURE THAT ALL INSTALLED WATERMAINS WILL HAVE THE REQUIRED COVER.

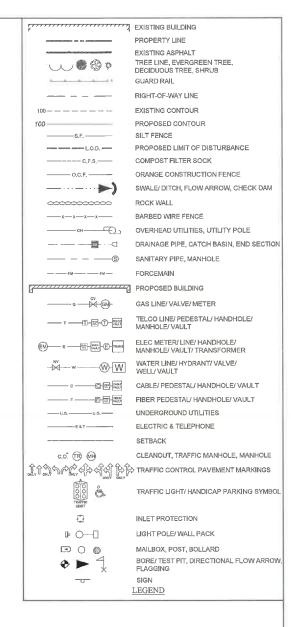



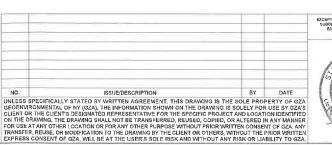

COUNTY LINE ROAD SUBDIVISION COUNTY LINE ROAD TOWN OF SKANEATELES, STATE OF NY

NOTES & LEGEND SHEET

GZA GeoEnvironmental of NY Engineers and Scientists www.gza.com GZN PROJ MGR E.K.R. REVIEWED BY: C.J.M. CHECKED BY: DESIGNED BY: E.K.R. DRAWN BY: E.K.R. SCALE: AS NOTED


DATE: PROJECT NO. REVISION NO.


31.0180302.00


JUNE 01, 2020


4331 JORDAN ROAD SKANEATELES, NEW YORK


GC002 SHEET NO. 02 OF 14

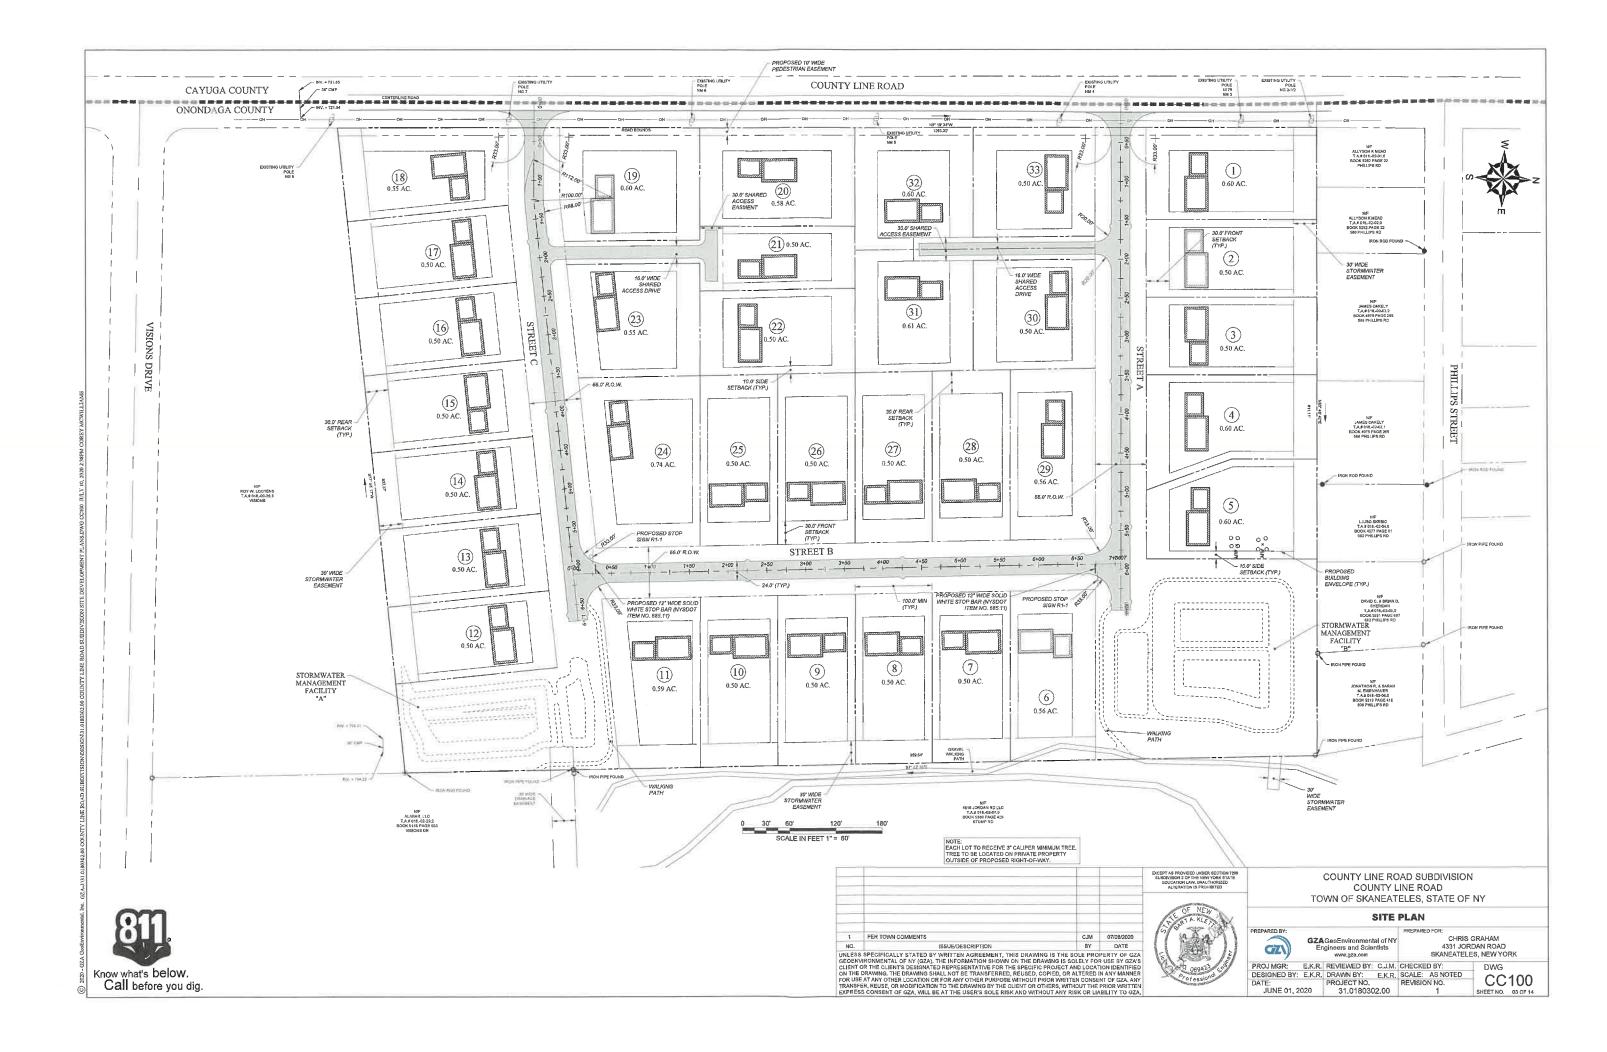


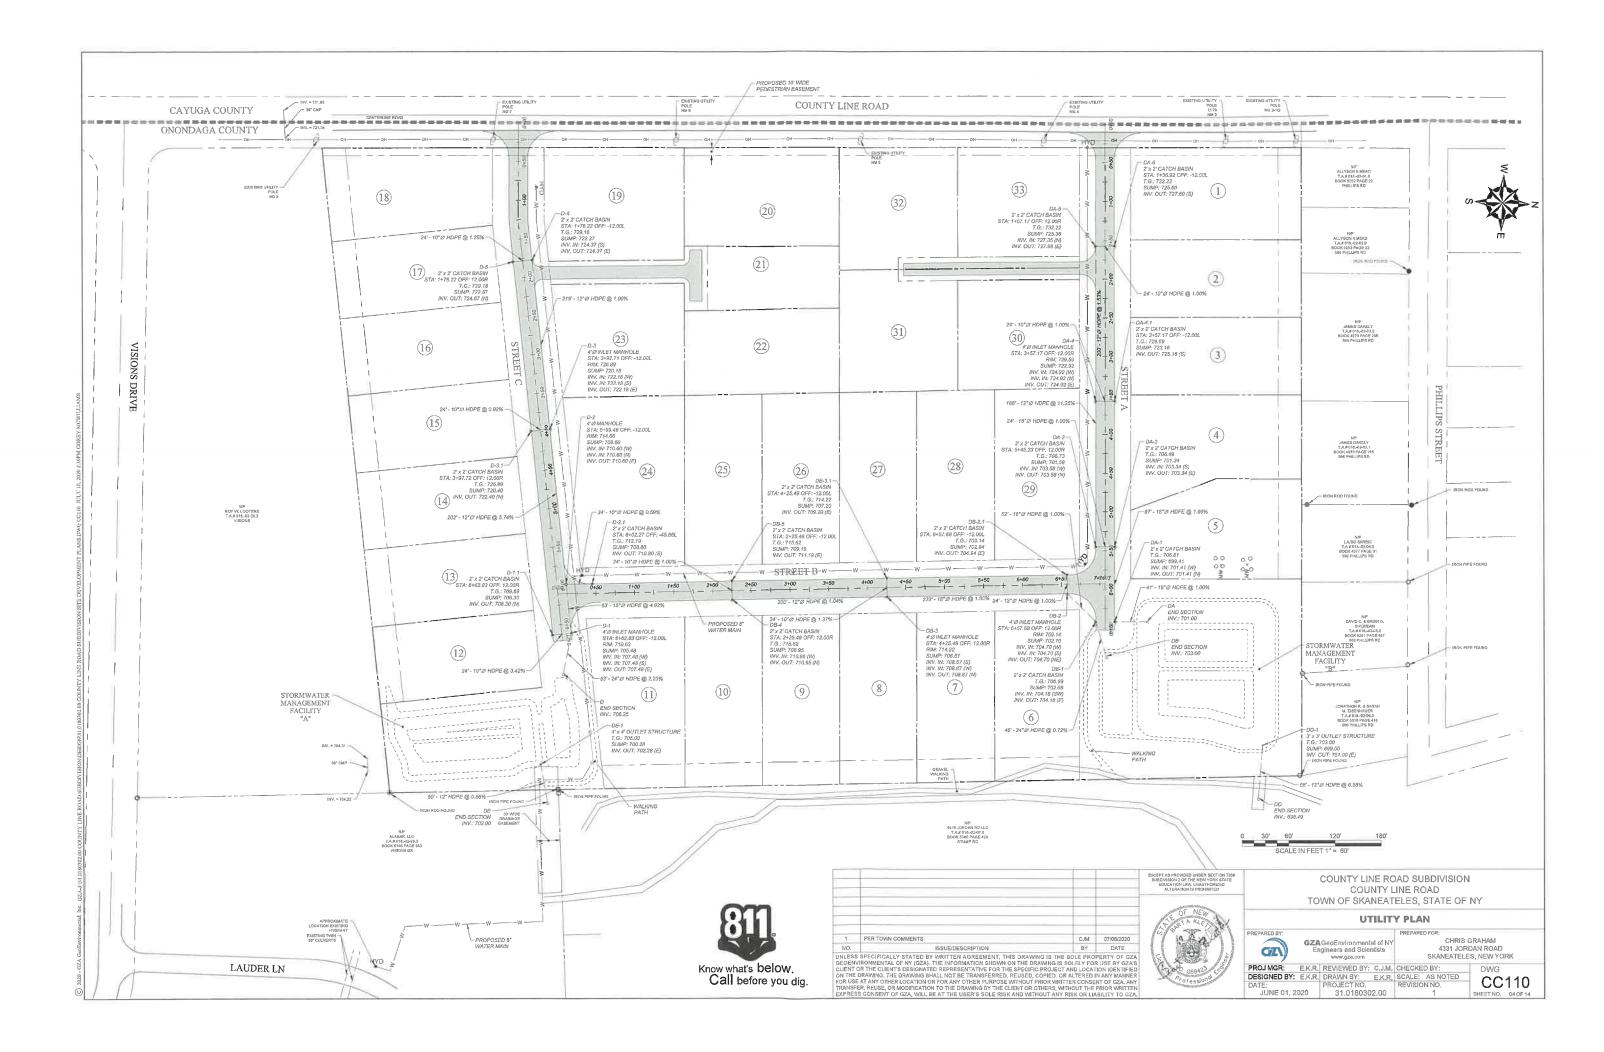


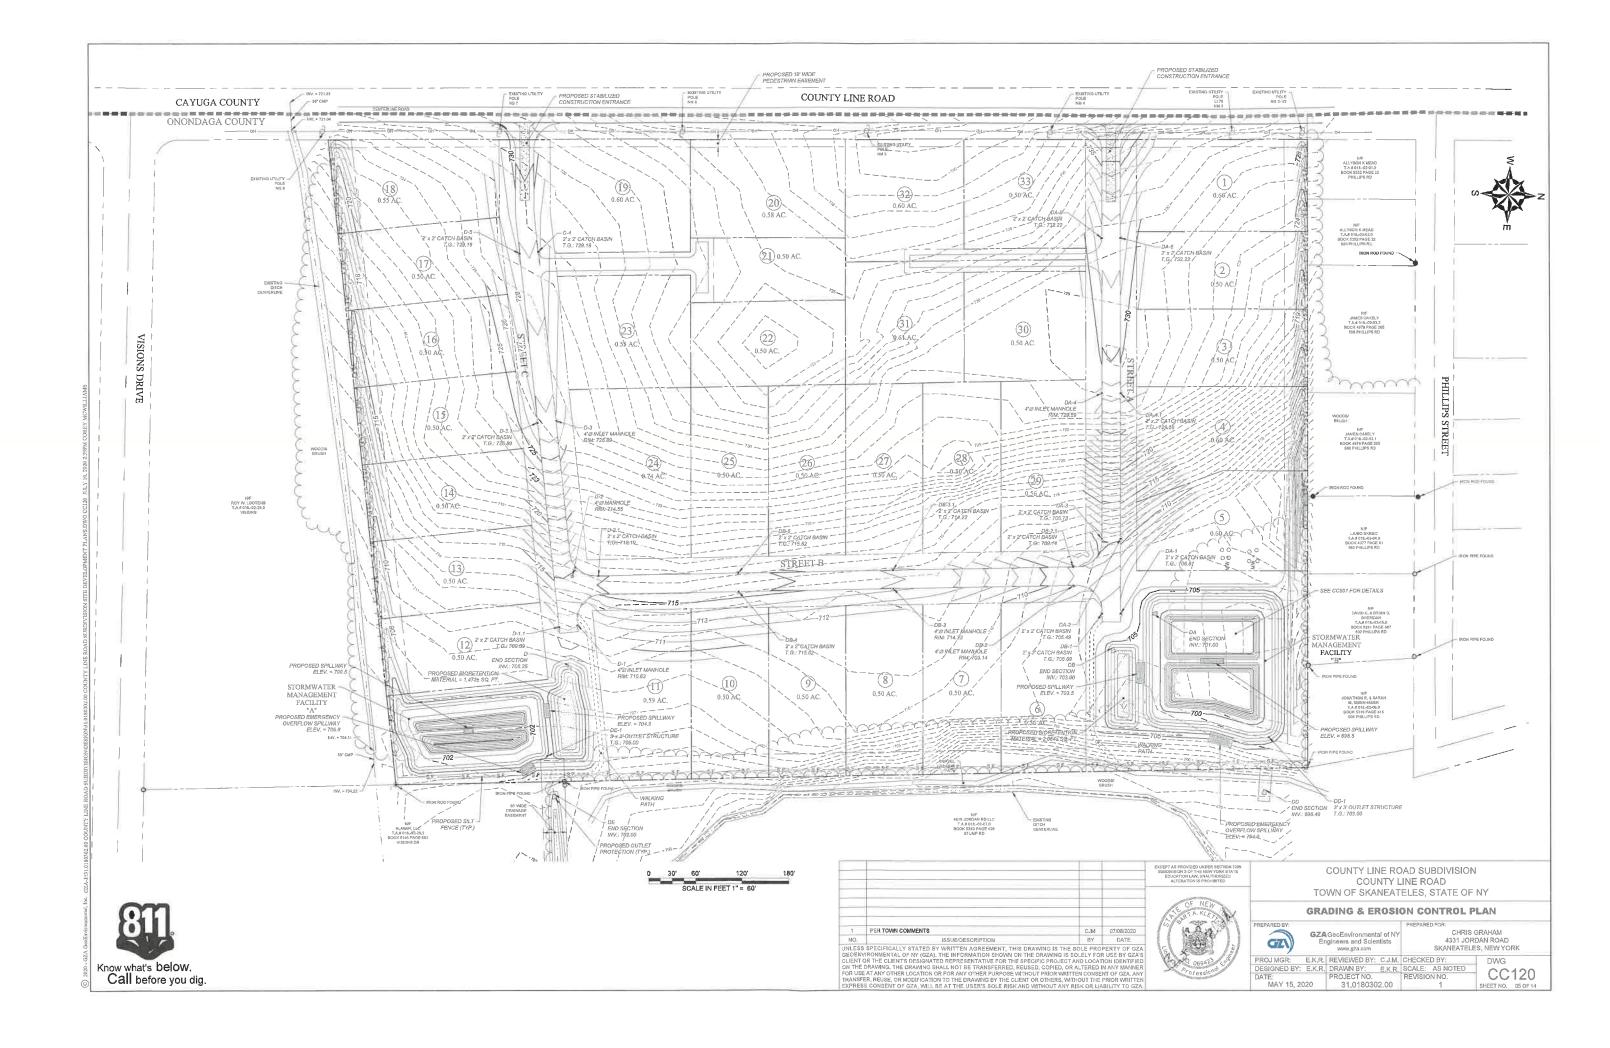


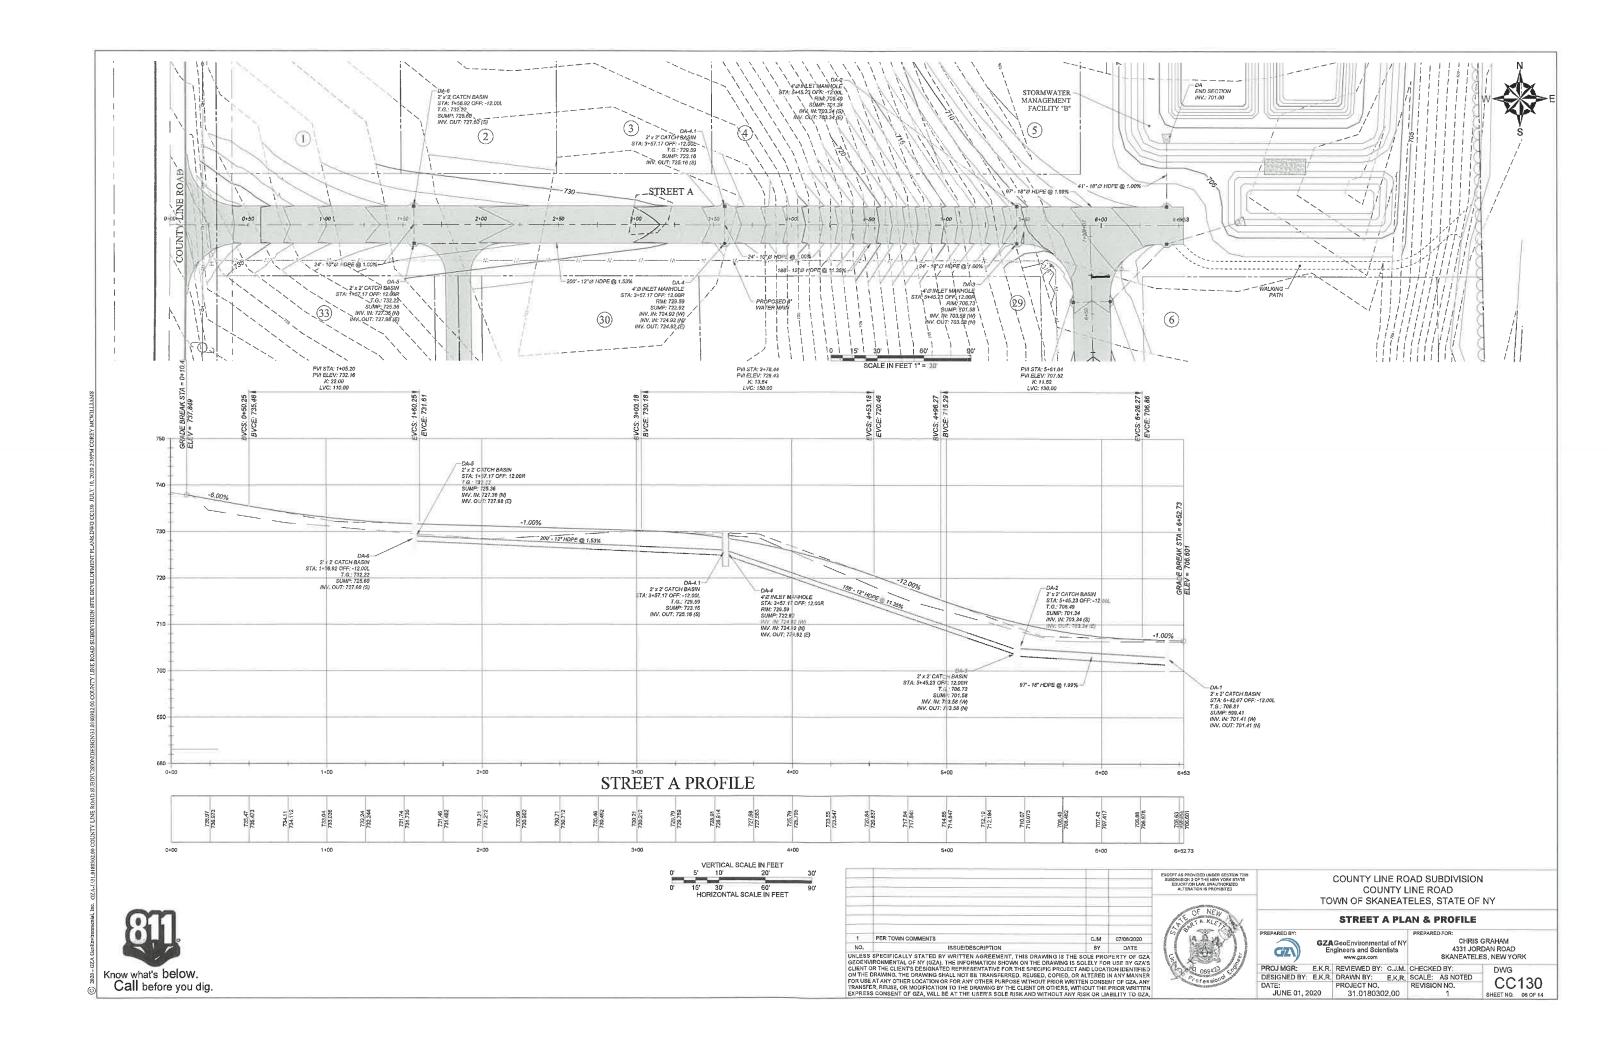


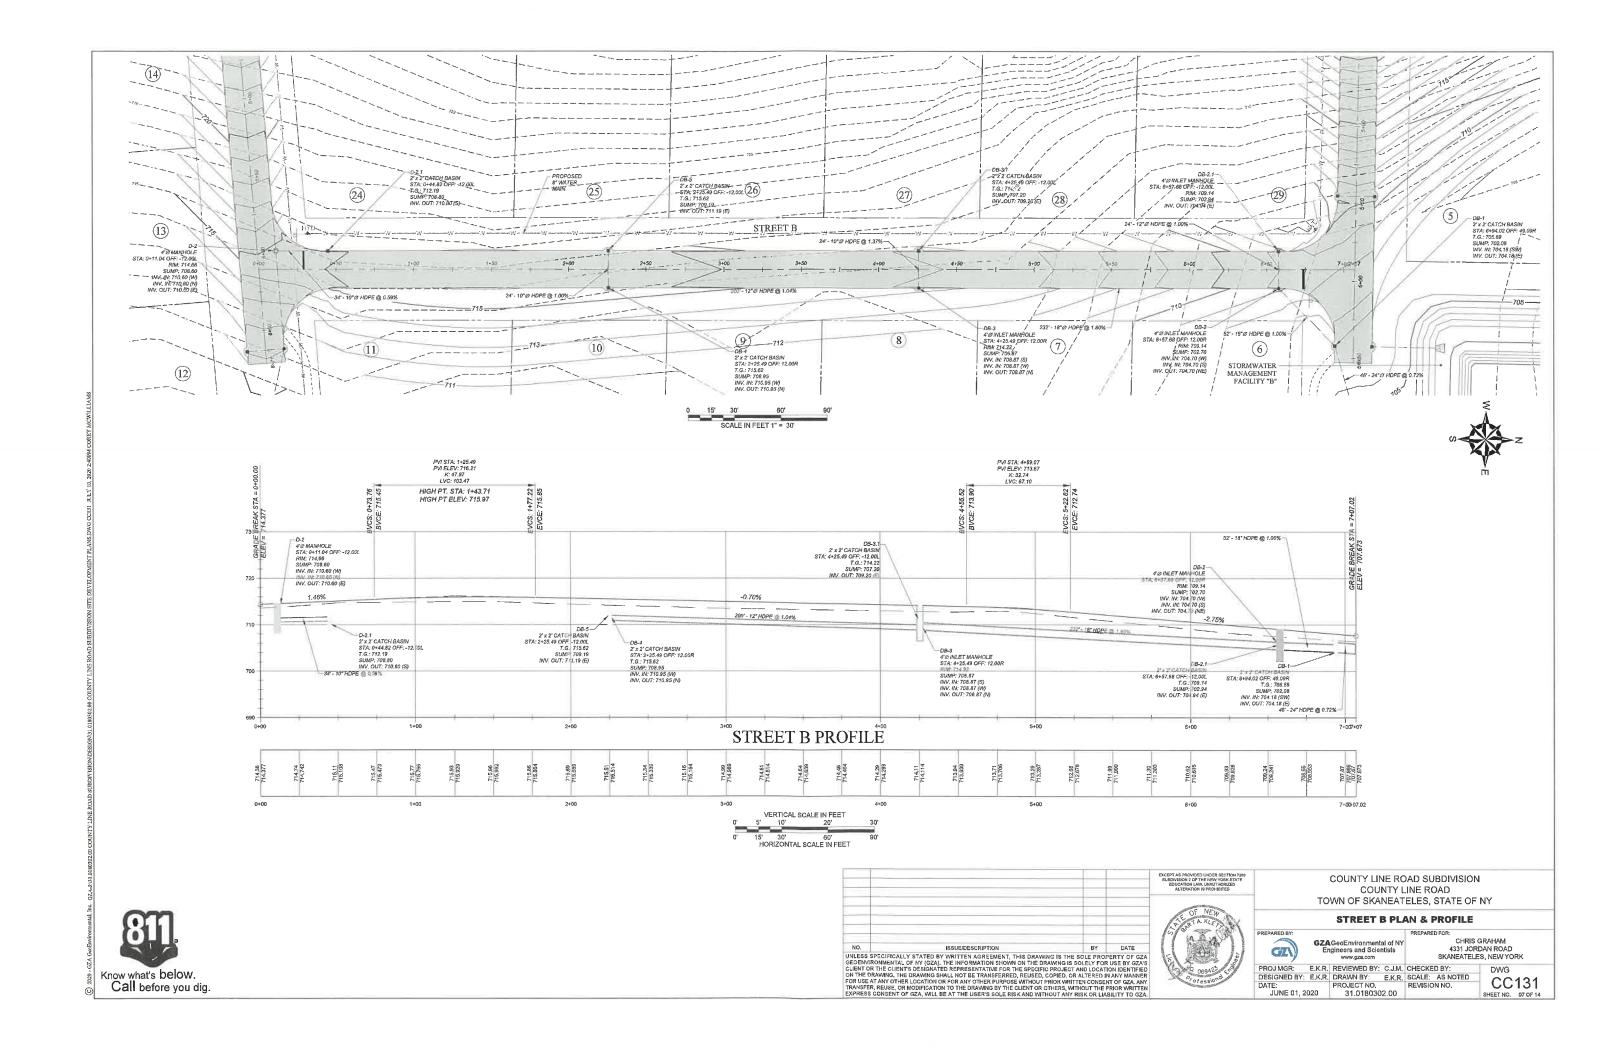

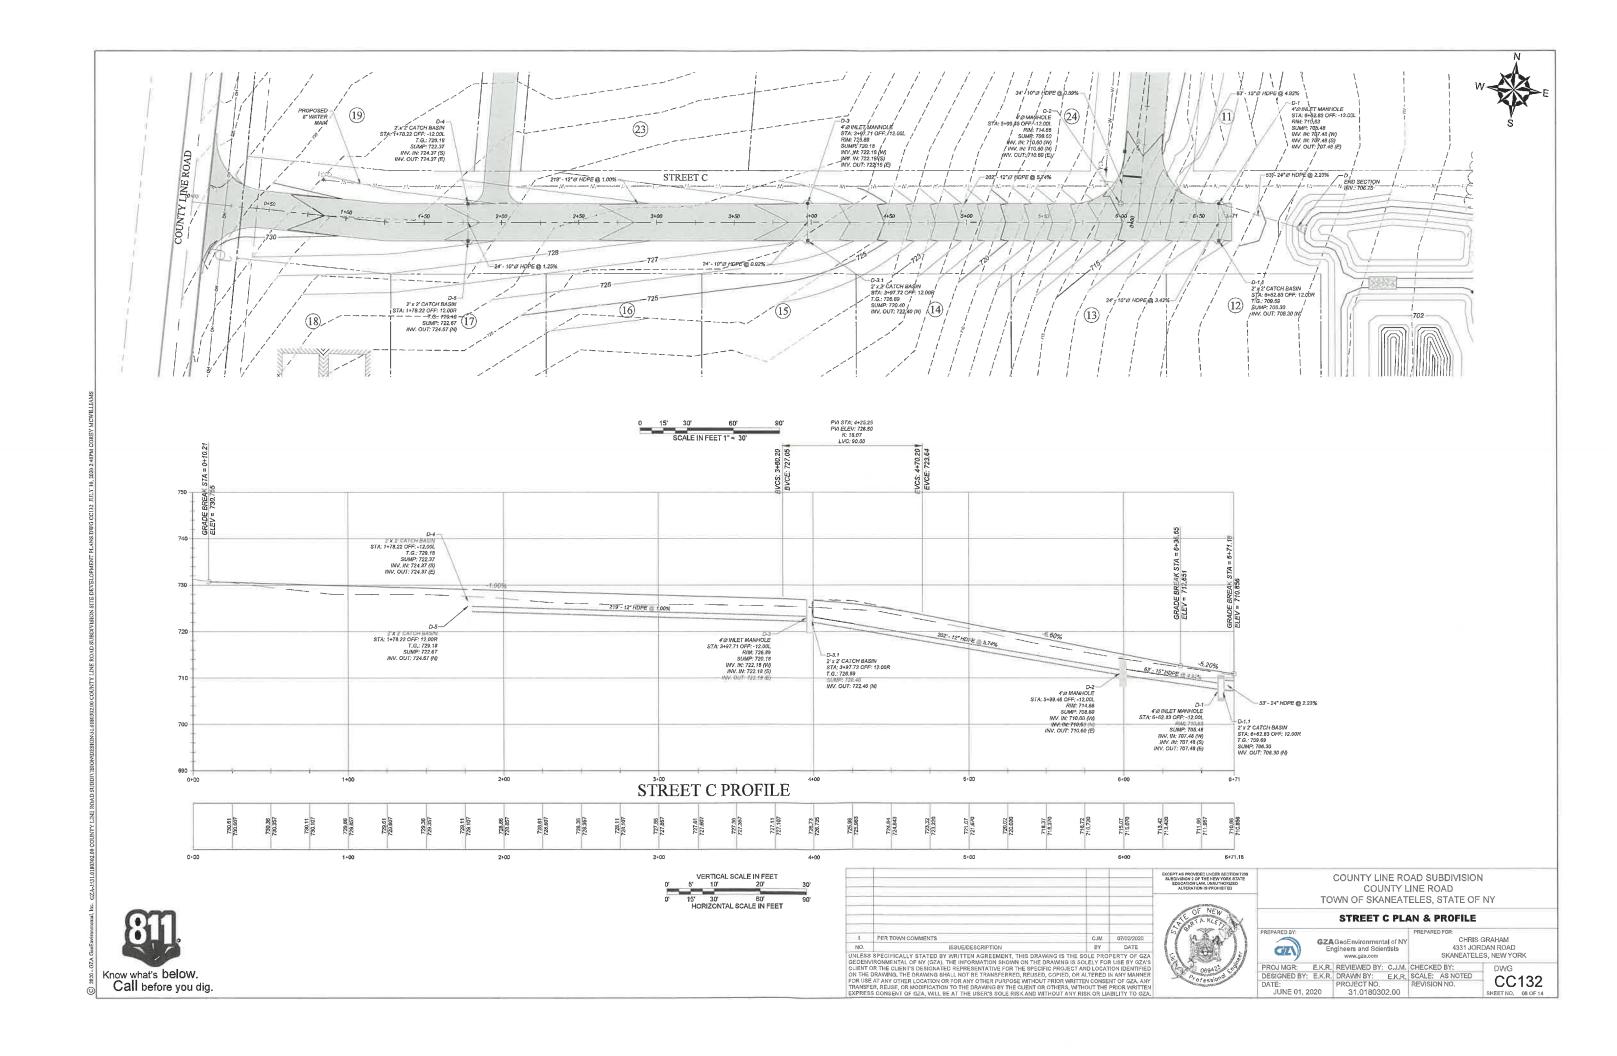


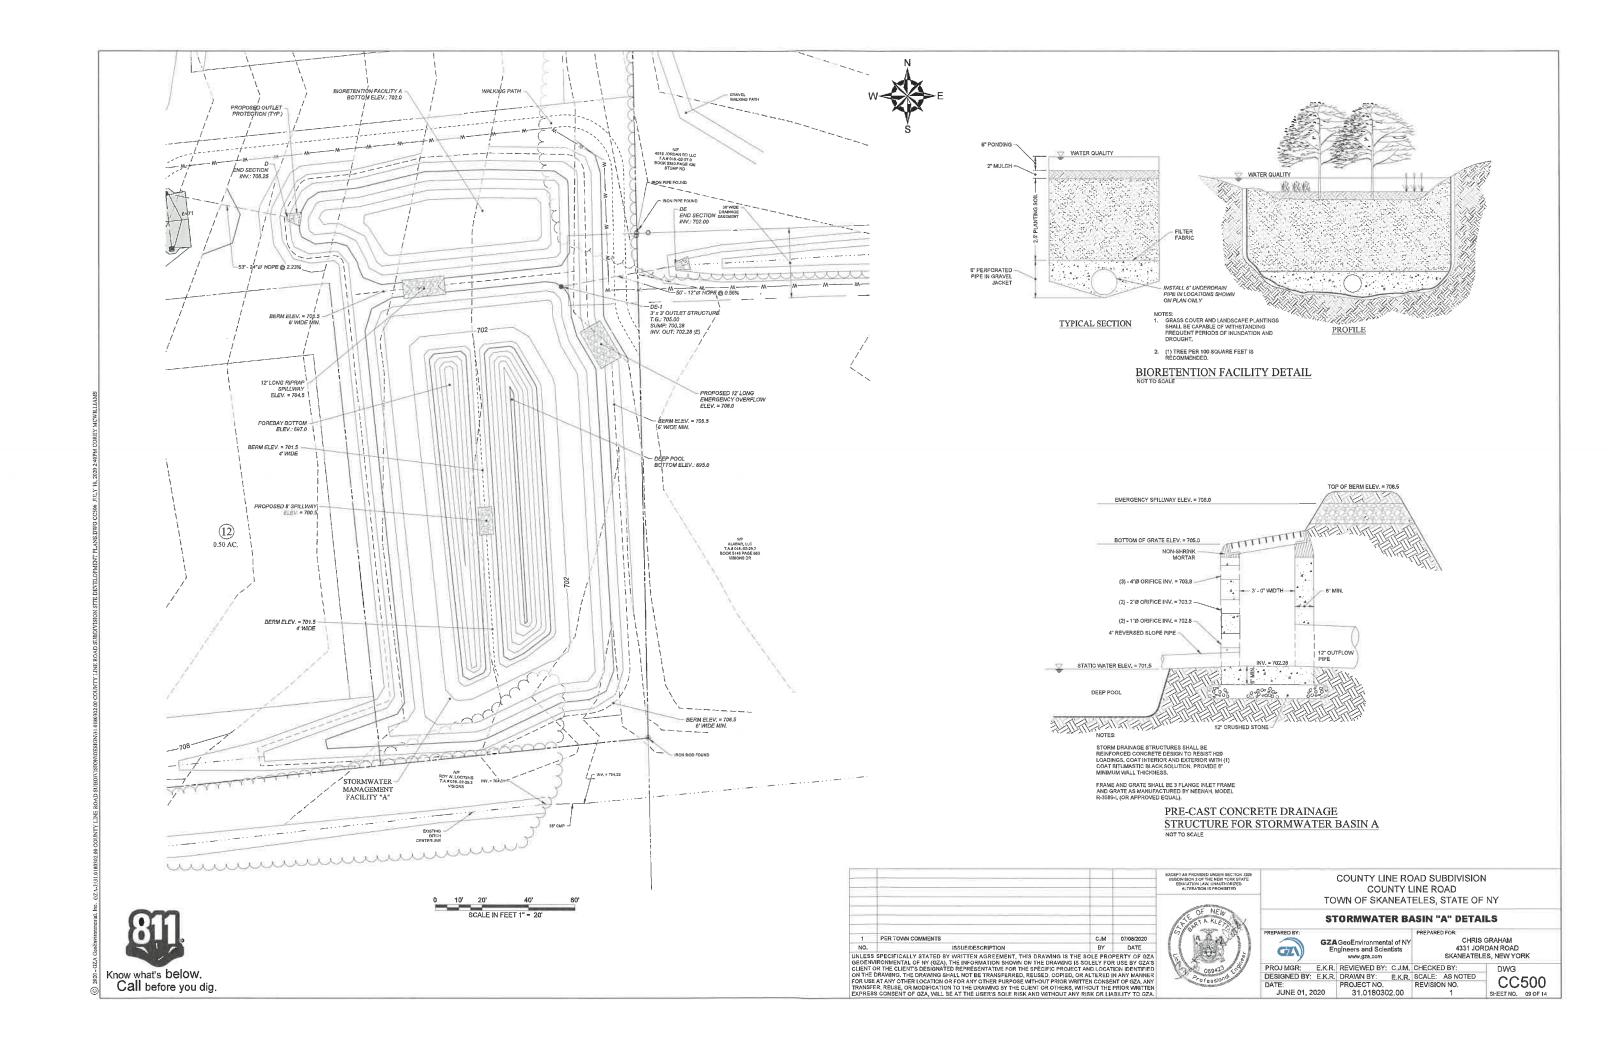

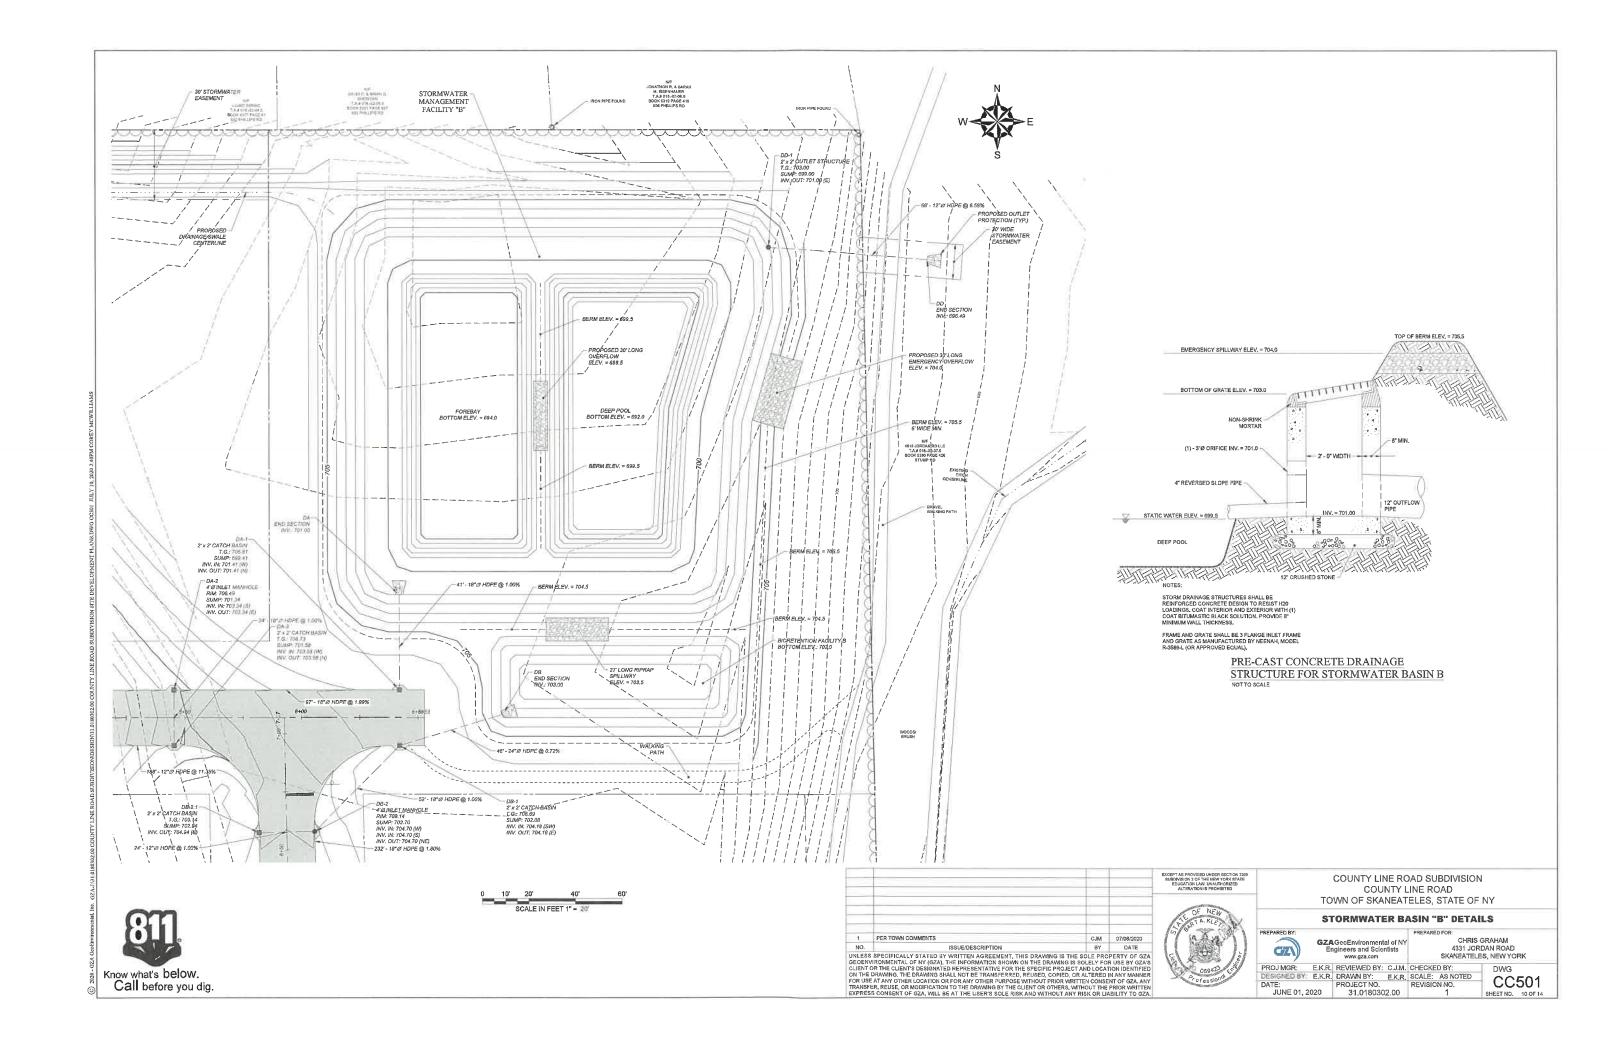

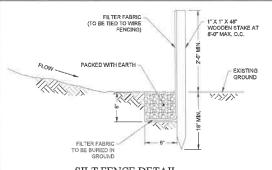


SILT FENCE DETAIL

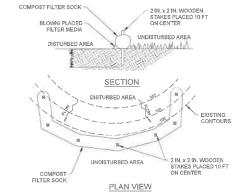

SOCK FABRIC SHALL MEET STANDARDS AND SPECIFICATIONS OUTLINED IN NYSDEC STORMWATER MANUAL.

- COMPOST FILTER SOCK SHALL BE PLACED AT EXISTING ELEVEL GRADE. BOTH ENDS OF THE BARRIER SHALL BE EXTENDED AT LEAST 8 FEET UP SLOPE AT 45 DEGREES TO THE MAIN BARRIER ALIGNMENT, MAXIMUM SLOPE LENGTH ABOVE ANY BARRIER SHALL NOT EXCEED THAT SPECIFIED FOR THE SIZE OF THE SOCK AND THE SLOPE OF ITS TRIBUTARY AREA.
- B. TRAFFIC SHALL NOT BE PERMITTED TO CROSS COMPOST FILTER SOCKS.
- ACCUMULATED SEDIMENT SHALL BE REMOVED WHEN IT REACHES 1/2 THE ABOVE GROUND HEIGHT OF THE BARRIER AND DISPOSED IN THE MANNER DESCRIBED ELSEWHERE IN THE
- BIODEGRADABLE COMPOST FILTER SOCKS SHALL BE REPLACED AFTER 6 MONTHS; PHOTODEGRADABLE SOCKS AFTER 1 YEAR, POLYPROPYLENE SOCKS SHALL BE REPLACED ACCORDING TO MANUFACTURER'S RECOMMENDATIONS.
- UPON STABILIZATION OF THE AREA TRIBUTARY TO THE SOCK, STAKES SHALL BE REMOVED, THE SOCK MAY BE LEFT IN PLACE AND VEGETATED OR REMOVED, IN THE LATTER CASE, THE MESH SHALL BE CUT OPEN AND THE MULCH SPREAD AS A SOIL SUPPLEMENT.


COMPOST FILTER SOCK

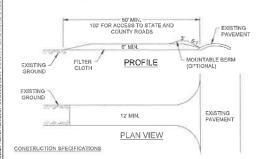


- STONE SIZE USE 2" STONE, OR RECLAIMED OR RECYCLED CONCRETE EQUIVALENT
- LENGTH NOT LESS THAN FIFTY (50) FEET (EXCEPT ON A SINGLE RESIDENCE LOT WHERE A THIRTY (30) FOOT MINIMUM LENGTH WOULD APPLY).
- I, THICKNESS NOT LESS THAN SIX (6) INCHES.
- WIDTH TWELVE (12) FOOT MINIMUM, BUT NOT LESS THAN THE FULL WIDTH AT POINTS WHERE INGRESS OR EGRESS OCCURS, TWENTY-FOUR (24) FOOT IF SINGLE ENTRANCE TO SITE.

- MAINTENANCE THE ENTRANCE SHALL BE MAINTAINED IN A CONDITION WHICH WILL PREVENT TRACKING OR FLOWING OF SEDIMENT ONTO PUBLIC RIGHTS-OF-WAY, ALL SEDIMENT SPILLED, ROPPED, WASHED OR TRACKED ONTO PUBLIC RIGHTS-OF-WAY MUST BE REMOVED IMMEDIATELY.
- WHEN WASHING IS REQUIRED, IT SHALL BE DONE ON A AREA STABILIZED WITH STONE AND WHICH DRAINS INTO AN APPROVED SEDIMENT TRACKING DEVICE.
- PERIODIC INSPECTION AND NEEDED MAINTENANCE SHALL BE PROVIDED AFTER EACH RAIN EVENT.


STABILIZED CONSTRUCTION ENTRANCE

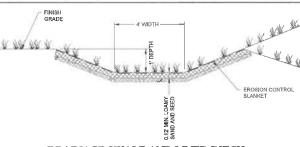

DRAINAGE SWALE AND LINED DITCH

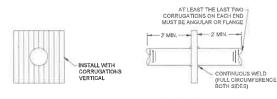


COLLAR WELDED IN PLACE ON BARREL SECTION

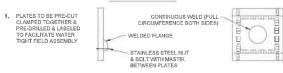

MULTI-PIECE COLLAR FOR LARGE PIPES




ANTI SEEP COLLAR

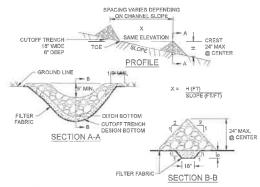

- STONE WILL BE PLACED ON A FILTER FABRIC FOUNDATION TO THE LINES, GRADES AND LOCATIONS SHOWN ON THE PLAN.
- SET SPACING OF CHECK DAMS AS INDICATED ON GRADING, EROSION AND SEDIMENT CONTROL PLAN.
- EXTEND THE STONE A MINIMUM OF 18" BEYOND THE DITCH BANKS TO PREVENT CUTTING AROUND THE DAM.
- PROTECT THE CHANNEL DOWNSTREAM OF THE LOWEST CHECK DAM FROM SCOUR AND EROSION WITH STONE OR LINER APPROPRIATE.
- ENSURE THAT CHANNEL APPURTENANCES, SUCH AS CULVERT ENTRANCES BELOW CHECK DAMS, ARE NOT SUBJECT TO DAMAGE OR BLOCKAGE FROM DISPLACED STONES.
- GRADED STONE SHALL BE BETWEEN 0.25" AND 1.5" IN SIZE, MEETING THE REQUIREMENTS OF NYSDOT ITEM NO. 620.03.
- 7. MAXIMUM DRAINAGE AREA = 2 ACRES


TEMPORARY CHECK DAM

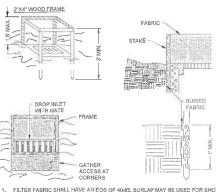

- FILTER FABRIC SHALL HAVE AN EOS OF 40-65, BURLAP MAY BE USED FOR SHORT TERM APPLICATIONS.
- CUT FABRIC FROM A CONTINUOUS ROLL TO ELIMINATE JOINTS. IF JOINTS ARE NEEDED THEY WILL BE OVERLAPPED TO THE NEXT STAKE.
- STAKE MATERIALS WILL BE STANDARD 2" x 4" WOOD OR EQUIVALENT METAL WITH A MINIMUM LENGTH OF 3 FEET.
- SPACE STAKES EVENLY AROUND INLET 3 FEET APART AND DRIVE A MINIMUM 18 INCHES DEEP, SPANS GREATER THAN 3 FEET MAY BE BRIDGED WITH THE USE OF WIRE MESH BEHIND THE FILTER FABRIC FOR SUPPORT.
- 5. FABRIC SHALL BE EMBEDDED 1 FOOT MINIMUM BELOW GROUND AND BACKFILLED, IT SHALL BE SECURELY FASTENED TO THE STAKES AND FRAME.
- A 2" x 4" WOOD FRAME SHALL BE COMPLETED AROUND THE CREST OF THE FABRIC FOR OVERFLOW STABILITY.
- 7. MAXIMUM DRAINAGE AREA 1 ACRE.

FILTER FABRIC INLET PROTECTION



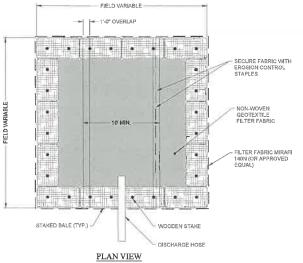


SECURE HOSE CROSS-SECTION

- NUMBER OF BALES MAY VARY DEPENDING ON SITE CONDITIONS
- THE BASIN TO BE SIZED TO PREVENT DISCHARGE WATER FROM OVERTOPPING BASIN.
- 3. KEEP AS FAR FROM WETLANDS AS PRACTICAL
- CLEAN AND REMOVE AS SOON AS DEWATERING IS COMPLETE.


1 PER TOWN COMMENTS

DEWATERING BASIN

NO. UNLESS SPECIFICALLY STATED BY WRITTEN AGREEMENT, THIS DRAWING IS THE SOLE PROPERTY OF GZA GEOGRAVIRONMENTAL OF NY (GZA), THE INFORMATION SHOWN ON THE DRAWING IS THE SOLE PROPERTY OF GZA GEOGRAVIRONMENTAL OF NY (GZA), THE INFORMATION SHOWN ON THE DRAWING IS SOLELY FOR USE BY GZAS CLIENTO RT THE CLIENTY DE SEIGNATED REPRESENTATIVE FOR THE SPECIFIC PROJECT AND LOCATION IDENTIFIED ON THE DRAWING, THE DRAWING SHALL NOT SE TRANSFERRED, REUSED, COPIED, OR ALTERED IN ANY MANNER FOR USE AT ANY OTHER LOCATION OR FOR ANY OTHER DURFHOR WRITTEN CONSENT OF GZA, ANY TRANSFER, REUSE, OR MODIFICATION TO THE DRAWING BY THE CLIENT OR OTHERS, WITHOUT THE PRICE WRITTEN LEFT OF THE PROPERTY OR THE STATE OF THE STATE

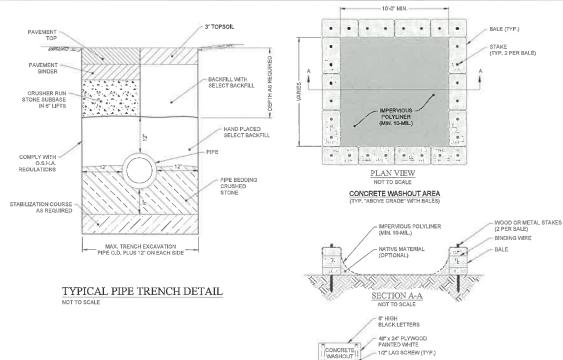

CONCRETE WASHOUT SIGN DETAIL (OR EQUIVALENT)

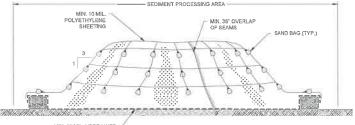

MIN. 20 MIL. HDPE LINER

NOTES:

- 1. STOCKPILES SHALL BE PLACED ON MINIMUM 20 MIL HDPE LINER.
- STOCKPILES SHALL BE COVERED WITH MINIMUM 10 MIL POLYETHYLENE SHEETING WHENEVER LOADING, STABILIZATION, OR PLACEMENT IS NOT OCCURING.
- STOCKPILE AREAS SHALL BE SUBJECT TO DUST/ODOR CONTROLS WHENEVER LOADING, STABILIZATION
 OR PLACEMEN IS O COURING AND AS DIRECTED BY ENGINEER. STOCKPILES SHALL BE COVERED WITH
 POLYETH/NEW WHEN THESE ACTIVITIES ARE NOT SEINOP PERFORMED.
- SHEETING COVERING STOCKPILE SHALL BE MAINTAINED TIGHTLY IN PLACE BY USING SAND BAGS ON ROPES WITH A MAXIMUM 10"-0" GRID SPACING IN ALL DIMENSIONS,
- 5. MINIMUM 36" OVERLAP OF ALL SEAMS REQUIRED,
- 6. STOCKPILE SIDE SLOPES SHALL SE NO STEEPER THAN 3 (HORIZONTAL) TO 1 (VERTICAL).
- CONTRACTOR SHALL PLACE STRAW BALE BERMS AS SHOWN ON THE DETAIL ABOVE AROUND STOCKPILES GENERATED OUTSIDE OF THE SEDIMENT PROCESSING AREA. STRAW BALE BERMS, AS SHOWN ON THE DETAIL, ARE NOT REQUIRED FOR STOCKPILES IN THE SEDIMENT PROCESSING AREA.

TYPICAL STOCKPILE DETAIL

CJM 07/08/2020

COUNTY LINE ROAD SUBDIVISION COUNTY LINE ROAD TOWN OF SKANEATELES, STATE OF NY

GZN

GZA GeoEnvironmental of NY Engineers and Scientists www.gza.com

SKANEATELES, NEW YORK

CC502

 PROJ MGR:
 E.K.R. REVIEWED BY:
 C.J.M. CHECKED BY:


 DESIGNED BY:
 E.K.R. DRAWN BY:
 E.K.R. SCALE:
 AS NOTED

 DATE:
 PROJECT NO.
 REVISION NO.
 JUNE 01, 2020 31.0180302.00

NUMBER OF BALES MAY VARY DEPENDING ON SITE CONDITIONS.

KEEP AS FAR FROM DRAINAGE CHANNELS AND WETLAND AREAS AS PRACTICAL.

SUMPS TO BE CLEANED AND WASTE CONCRETE REMOVED AND PROPERLY DISPOSED OF UPON COMPLETION OF WORK.

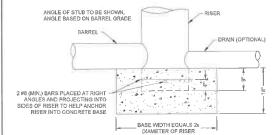

CONSTRUCTION SPECIFICATIONS


- THE CONCRETE BASE SHALL BE POURED IN SUCH A MANNER TO INSURE THAT THE CONCRETE FILLS THE BOTTOM OF THE RISER TO THE INVERT OF THE OUTLET PIPE TO PREVENT THE RISER FROM THE BREAKING AWAY FROM THE BASE.
- WITH ALUMINUM OR ALUMINIZED PIPE, THE EMBEDDED SECTION MUST BE PAINTED WITH CHROMATE OR EQUIVALENT.
- RISER BASE MAY BE SIZED AS COMPUTED USING FLOTATION WITH A FACTOR OF SAFETY OF 1.2.

RISER DETAIL NOT TO SCALE

RISER PIPE CONSTRUCTION NOTES;


- STANDPIPE AND CONNECTOR PIPE SHALL BE A MINIMUM OF 6 INCHES DIAMETER.
- METAL PIPE MAY BE GALVANIZED STEEL OR ALUMINUM; PLASTIC PIPE MAY BE SCHEDULE 40 PVC OR HDPP.
- CONSTRUCTION OPERATIONS SHALL BE CARRIED OUT IN SUCH A MANNER THAT EROSION AND WATER POLLUTION ARE MINIMIZED.
- 4. THE STRUCTURE SHALL ONLY BE REMOVED WHEN THE CONTRIBUTING DRAINAGE AREA HAS BEEN PROPERLY STABILIZED.
- ALL PIPE CONNECTIONS SHALL BE WATERTIGHT. THE LOWER PORTION OF THE STANDPIPE, AT A POINT ABOVE THE BARREL CONNECTION, SHALL BE FITTED WITH AN INTERNAL ORFICE PLATE SIZED TO RELEASE THE VOLUME OF THE BASIN NO SOONER THAN 48 HOURS.
- THE TOP 2/3 OF THE STANDPIPE SHALL BE PERFORATED WITH 1 INCH DIAMETER OR HOLE SLIT SPACED 6 INCHES VERTICALLY AND HORIZONTALLY AND PLACED IN THE CONCAVE PORTION OF THE PIPE. NO HOLES WILL BE ALLOWED WITHIN 6 INCHES OF THE HORIZONTAL CONNECTOR PIPE.
- THE RISER SHALL BE WRAPPED WITH A TYPE GD-11 GEOTEXTILE FABRIC, THE FABRIC SHALL EXTEND 6 INCHES ABOVE THE HIGHEST HOLE AND 6" BELOWTHE LOWEST HOLE, WHERE ENDS OF FABRIC COME TOGETHER, THEY SHALL BE OVERLAPPED, FOLDED AND STAPLED TO PREVENT BYPASS.
- STRAPS OR CONNECTING HANDS SHALL BE USED TO HOLD THE FABRIC AND WIRE MESH (AS NEEDED) IN PLACE, THEY SHALL BE PLACED AT THE TOP AND BOTTOM OF THE CLOTH,
- 9. THE STANDPIPE SHALL BE ANCHORED WITH THE EITHER CONCRETE BASE OR STEEL PLATE BASE TO PREVENT FLOTATION. CONCRETE BASES SHALL BE 12 INCHES THICK WITH THE STANDPIPE EMBEDDED NINE INCHES. STEEL PLATE BASES WILL BE 1/4 INCH MINIMUM THICKNESS ATTACHED TO THE STANDPIPE BY A CONTINUOUS WILL JAROUND THE BOTTOM TO FORM A WATERTIGHT CONNECTION. THE PLAYE SHALL HAVE 2.5 FEET OF STONE, GRAVEL OR TAMPERED EARTH FLACED ON 1T.
- THE PERFORATED STANDPIPE SHALL BE SURROUNDED BY NYSDOT #1 OR #2 STONE OR A BLEND OF BOTH TO PROTECT THE FILTER FABRIC.

RISER NOTES

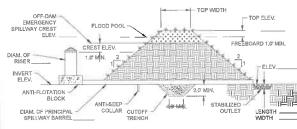



PRINCIPAL SPILLWAY PROFILE

MAXIMUM DRAINAGE AREA = 50 ACRES

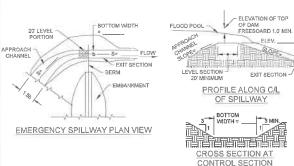

SEDIMENT BASIN DETAILS

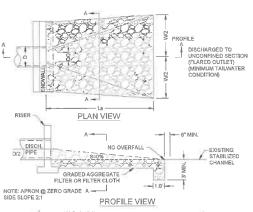

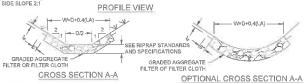


 THE SUBGRADE FOR THE RIPRAP OUTLET, SHALL BE PREPARED TO THE REQUIRED LINES AND GRADES, ANY FILL REQUIRED IN THE SUBGRADE SHALL BE COMPACTED TO A DENSITY OF OF APPROXIMATELY THAT OF THE SURROUNDING MUNISTREED MATERIAL.

CONSTRUCTION SPECIFICATIONS


- 2. THE ROCK OR GRAVEL SHALL CONFORM TO THE SPECIFIED GRADING LIMITS RESPECTIVELY IN THE RIPRAP OR FILTER.
- FILTER CLOTH SHALL BE PROTECTED FROM PUNCHING, CUTTING, OR TEARING, ANY DAMAGE OTHER THAN AN
 OCCASIONAL SMALL HOLE SHALL BE REPAIRED BY PLACING ANOTHER PIECE OF CLOTH OVER THE DAMAGED
 PART OR BY COMPLETELY REPLACING THE CLOTH ALL OVERLAPS, WHETHER FOR REPAIRS OR FOR JOINING
 TWO PIECES OF CLOTH SHALL BE A MINIMUM OF ONE FOOT.
- 4. ROCK FOR THE RIPRAP OUTLETS MAY BE PLACED BY EQUIPMENT, BOTH SHALL EACH BE CONSTRUCTED TO THE FULL COURSE THICKNESS IN ONE OPERATION AND IN SUCH A MANNER AS TO AVOID DISPLACEMENT OF UNDERLYING MATERIAS. THE ROCK FOR PIPRAP DUTLETS SHALL BE DEUVERED AND FLACED IN A MANNER THAT WILL ENSURE THAT IT IS REASONABLY HOMOGENOUS WITH THE SMALLER ROCKS AND SPALLS FILLING THE VOIDS BETWEEN THE LARGER ROCKS, IPPAPS "HALL BE PLACED IN A MANNER TO FREVENT DAMAGE TO THE FILTER BLANKET OR CLOTH, HAND PLACEMENT MILL BE REQUIRED TO THE EXTEND NECESSARY TO PREVENT DAMAGE TO THE PERMANENT WORKS.
- 5. RIPRAP SHALL BE COMPOSED OF A WELL-GRADED MIXTURE OF ROCK SIZE SO THAT 50 PERCENT OF THE PIECES, BY WEIGHT, SHALL BE LARGER THAN THE DISO SIZE. THE DIAMETER OF THE LARGEST ROCK SIZE SHALL BE 1.5 TIMES THE DISO SIZE.
- THE MINIMUM THICKNESS OF THE RIPRAP LAYER SHALL BE 1,5 TIMES THE MAXIMUM ROCK DIAMETER FOR D50
 OF 15 INCHES OR LESS; AND 1.2 TIMES THE ROCK SIZE FOR D50 GREATER THAN 15 INCHES.

RIPRAP OUTLET PROTECTION

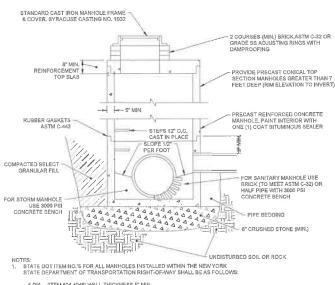


- 4 D(A, (ITEM 604,4048) WALL THICKNESS 5" MIN. 5" DIA, (ITEM 604,4060) WALL THICKNESS 6" MIN.
- 5' DIA, (ITEM 604.4060) WALL THICKNESS 6" MIN. 6' DIA. - (ITEM 604.4072) WALL THICKNESS 7" MIN. 8' DIA. - (ITEM 604.4096) WALL THICKNESS 9" MIN.
- 2. ALL BENCHWORK (MITHIN STORM AND SANITARY MANHOLES SHALL BE PAINTED WITH ONE (1) COAT OF BITUMINOUS SEALER.

STANDARD MANHOLE DETAIL

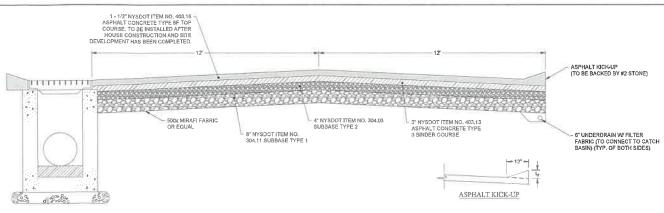


TYPICAL ROAD CROSS-SECTION

NOT TO SCALE

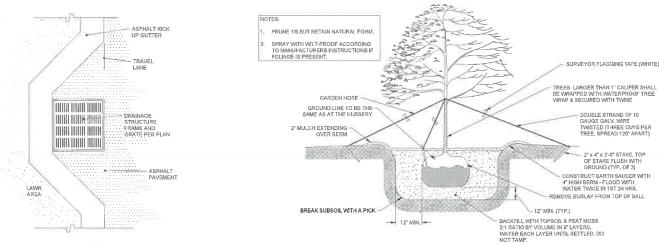

ASPHALT APRON @ INLET DETAIL

TREE PLANTING DETAIL

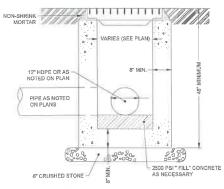

NOTES:

1. STORMWATER INLETS SHALL BE REINFORCED CONCRETE DESIGN TO RESIST HOS LOADINGS. COAT INTERIOR AND EXTERIOR WITH ONE (1) COAT SITUMASTIC BLACK SOLUTION. PROVIDE 8" MINIMUM WALL THICKNESS.

 FRAME AND GRATE SHALL BE 4 FLANGE FRAME AND GRATE AS MANUFACTURED BY NEENAH.

PRE-CAST CONCRETE INLETS



DESCRIPTION OF SECULAR VIEW SEC

COUNTY LINE ROAD SUBDIVISION COUNTY LINE ROAD TOWN OF SKANEATELES, STATE OF NY

DETAILS

PREPARED BY:

G

PROJ MGR: E.K

PREPARED FOR:


CHRIS GRAHAM


CHRIS GRAHAM


4331 JORDAN ROAD


SKANEATELES, NEW YORK


PROJ MGR: E.K.R. REVIEWED BY: C.J.M. CHECKED BY:
DESIGNED BY: E.K.R. DRAWN BY: E.K.R. SCALE: AS NOTED
DATE: PROJECT NO.
JUNE 01, 2020 31.0180302.00 1 1 SHEET NO. 12.0F14

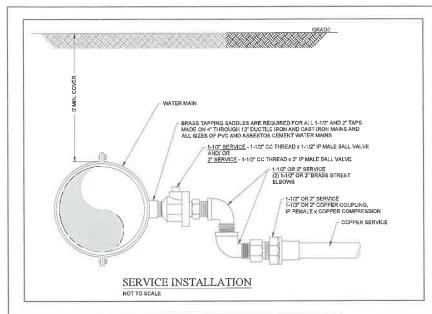


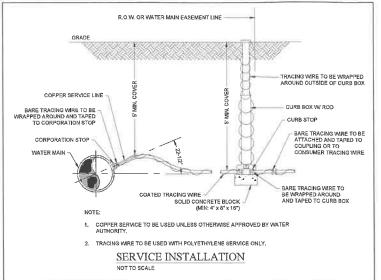


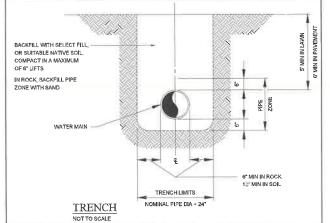


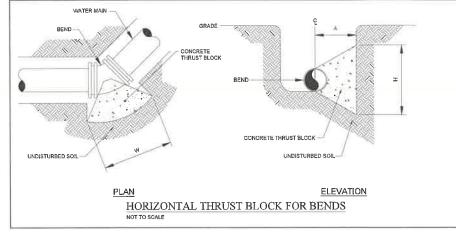


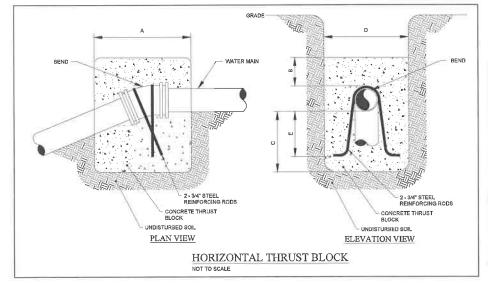

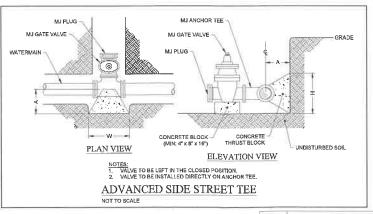

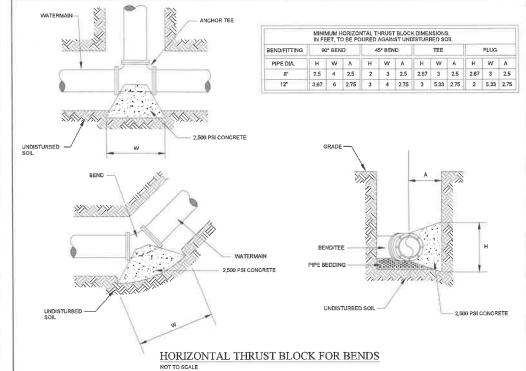

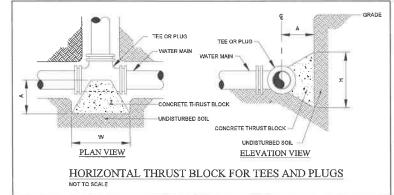

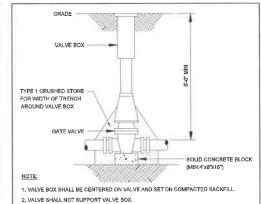

- 3. ALL BODY AND BONNET BOLTS SHALL BE STAINLESS STEEL.
- 4. ALL VALVES SHALL BE OPEN LEFT EXCEPT VALVES 12" AND SMALLER INSTALLED IN THE TOWN OF WEBSTER (WHICH SHALL BE OPEN RIGHT).

VALVE

				EDUCATION LAW, UNAUTHORIZE ALTERATION IS PROHIBITED
				OF NEW ACTOR
_ 1	PER TOWN COMMENTS	CJM	07/08/2020	In All Ma
NO.	ISSUE/DESCRIPTION	BY	DATE	
GEOENV CLIENT ON THE FOR USE TRANSF	SPECIFICALLY STATED BY WRITTEN AGREEMENT, THIS DRAWNI IRROMMENTAL OF NY (GZA). THE INFORMATION SHOWN ON THE DR. OR THE CLIENTS DESIGNATED REPRESENTATIVE FOR THE SPECIFIC BY ANY OTHER LOCATION OR FOR ANY OTHER PUPPOSE WITHOUT F.R. REUSE, OR MODIFICATION TO THE DRAWNING BY THE CLIENT OR O. S CONSENT OF GZA, WILL BE AT THE USER'S SUCE RISK AND WITH	AWING IS SOLELY FOR PROJECT AND LOCAT COPIED, OR ALTERED I RIOR WRITTEN CONSE THERS, WITHOUT THE	R USE BY GZA'S FION IDENTIFIED IN ANY MANNER INT OF GZA, ANY PRIOR WRITTEN	Management of the second of th

EXCEPT AS PROVIDED UNDER SECTION 7209 SUBDIVISION 2 OF THE NEW YORK STATE

COUNTY LINE ROAD SUBDIVISION COUNTY LINE ROAD TOWN OF SKANEATELES, STATE OF NY

WATER SERVICE DETAILS


GZAGeoEnvironmental of NY Engineers and Scientists www.gza.com GZN

PROJ MGR:

CHRIS GRAHAM 4331 JORDAN ROAD SKANEATELES, NEW YORK

E.K.R. REVIEWED BY: C.J.M. CHECKED BY: DESIGNED BY: E.K.R. DRAWN BY: E.K.R. SCALE: AS NOTED
DATE: PROJECT NO. 31.0180302.00 1

CC504

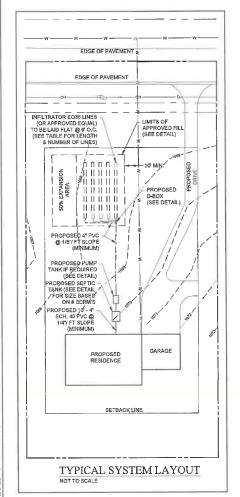



3 BEDROOM 4 BEDROOM


207 - 4 LINES @ 52 275' - 5 LINES @ 56'


EQ36

EQ36

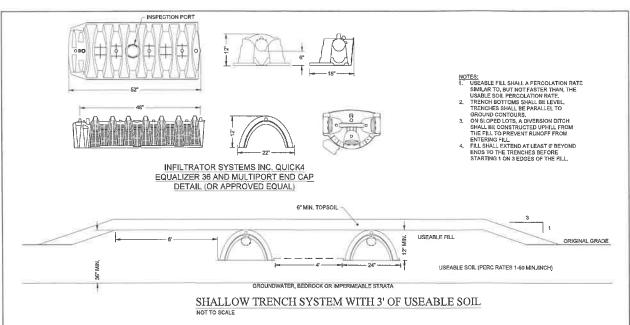

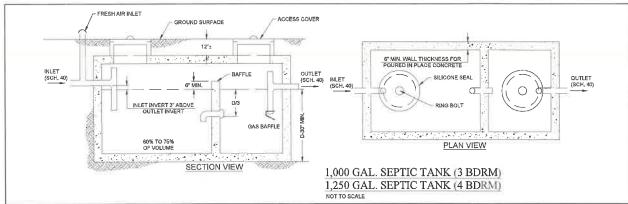


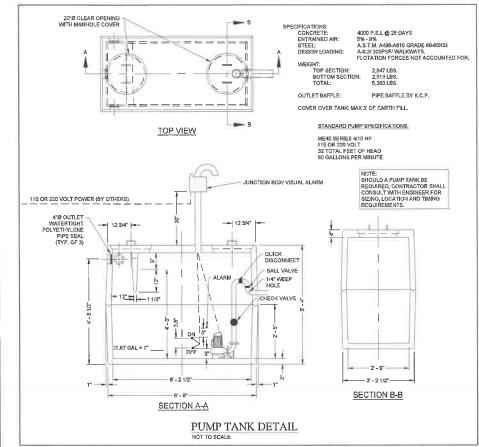

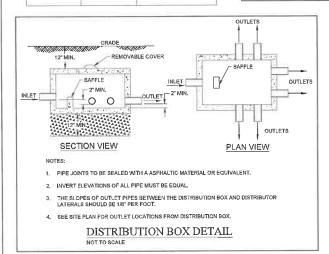

TYPE

SHALLOW TRENCH

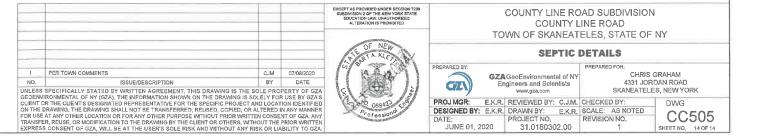

2020 - GZA GeoFaviroamental. Inc. GZA-F\31 0180302 00 COUNTY LINE ROAD